

YORK COUNTY MOSS JUSTICE CENTER KITCHEN FLOORING REPLACEMENT

15 SOUTH MAIN STREET, SUITE 400 GREENVILLE, SC 29601

GENERAL NOTES

- A. THE TERM "WORK" AS USED IN THESE NOTES SHALL INCLUDE ALL PROVISIONS AS DRAWN OR SPECIFIED IN THESE DOCUMENTS AS WELL AS ALL OTHER PROVISIONS SPECIFICALLY INCLUDED BY THE OWNER IN THE FORM OF DRAWINGS, SPECIFICATIONS, AND WRITTEN INSTRUCTIONS AND APPROVED BY THE ARCHITECT.
- B. THE TERM "CONTRACTOR" AS USED IN THESE NOTES SHALL REFER TO THE GENERAL CONTRACTOR OR TO THE SUB-CONTRACTORS. THE OWNER MAY ELECT TO CONTRACT DIRECTLY WITH A SUB-CONTRACTOR FOR ANY PART OF THE WORK.
- C. SCOPE OF WORK: THE CONTRACTOR SHALL INCLUDE AND PROVIDE ALL LABOR, MATERIALS, EQUIPMENT, TRANSPORTATION, AND PAY ALL EXPENSES INCURRED IN THE PROPER COMPLETION OF WORK UNLESS SPECIFICALLY NOTED TO BE THE WORK OF OTHERS. CONTRACTOR SHALL PERFORM ALL WORK NECESSARY FOR PRODUCING A COMPLETE, HABITABLE PROJECT, INCLUDING BUT NOT LIMITED TO SITE WORK, ARCHITECTURAL STRUCTURAL FIRE PROTECTION PLUMBING HVAC AND ELECTRICAL
- D. BEFORE CONSTRUCTION BEGINS, THE CONTRACTOR SHALL VISIT THE SITE TO VERIFY ALL EXISTING DIMENSIONS AND CONDITIONS AND SHALL NOTIFY THE ARCHITECT. IN WRITING, OF ANY DISCREPANCIES BEFORE PROCEEDING WITH THE WORK AND SHALL BE RESPONSIBLE FOR SAME.
- E. IF THE CONTRACT DOCUMENTS ARE FOUND TO BE UNCLEAR, AMBIGUOUS OR CONTRADICTORY, THE CONTRACTOR MUST REQUEST CLARIFICATION FROM THE ARCHITECT IN WRITING BEFORE PROCEEDING WITH THAT PART OF THE WORK.
- F. IF A CONDITION EXISTS THAT REQUIRES OBSERVATION OR ACTION BY THE ARCHITECT, OR OTHER DESIGN PROFESSIONAL, THE CONTRACTOR SHALL NOTICY THE ARCHITECT
- G. CONTRACTOR SHALL BE FAMILIAR WITH PROVISIONS OF ALL APPLICABLE CODES AND SHALL ENSURE THE COMPLIANCE OF THE WORK WITH ALL LOCAL, STATE AND FEDERAL CODES, TRADE STANDARDS AND MANUFACTURER'S RECOMMENDATIONS. IN THE EVENT OF CONFLICT BETWEEN LOCAL, STATE AND NATIONAL CODES, THE MORE STRINGENT SHALL GOVERN. BEFORE COMMENCING WORK NOT SHOWN IN DOCUMENTS, BUT REQUIRED TO ACHIEVE FULL COMPLIANCE WITH CODES, CONTRACTOR SHALL NOTIFY ARCHITECT.
- H. THESE DOCUMENTS DO NOT INCLUDE THE NECESSARY COMPONENTS FOR CONSTRUCTION SAFETY. SAFETY, COMPLIANCE WITH STATE AND FEDERAL REGULATIONS REGARDING SAFETY AND COMPLIANCE WITH REQUIREMENTS SPECIFIED IN THE OWNER/CONTRACTOR CONTRACT IS, AND SHALL BE, THE CONTRACTOR'S RESPONSIBILITY.
- I. CONTRACTOR SHALL PAY ALL TAXES, SECURE ALL PERMITS AND PAY ALL FEES INCURRED IN THE COMPLETION OF THE PROJECT.
- J. THE CONTRACTOR SHALL UNCONDITIONALLY WARRANTY ALL MATERIALS, AND WORKMANSHIP FURNISHED OR INSTALLED BY HIM OR HIS SUBCONTRACTORS FOR A PERIOD OF ONE (1) YEAR FROM DATE OF ACCEPTANCE AND SHALL REPLACE ANY DEFECTIVE WORK WITHIN THAT PERIOD WITHOUT EXPENSE TO THE OWNER AND PAY FOR ALL DAMAGES TO OTHER PARTS OF THE BUILDING RESULTING FROM DEFECTIVE WORK OR ITS REPAIR. THE CONTRACTOR SHALL REPLACE DEFECTIVE WORK WITHIN A REASONABLE, AGREED UPON TIME FRAME, AFTER IT IS BROUGHT TO HIS ATTENTION.
- K. THE CONTRACTOR SHALL AT ALL TIMES KEEP THE PREMISES FREE FROM ACCUMULATION OF WASTE MATERIALS AND RUBBISH AND AT THE COMPLETION OF THE WORK THE CONTRACTOR SHALL REMOVE ALL RUBBISH, IMPLEMENTS, AND SURPLUS MATERIALS AND LEAVE THE BUILDING IN NEW AND CLEAN CONDITION.
- L. CONTRACTOR IS TO PROVIDE TO THE OWNER A LIST OF ALL SUBCONTRACTORS USED, COMPLETE WITH ADDRESSES, PHONE NUMBERS AND COPIES OF ALL WARRANTIES AND OPERATIONS AND MAINTENANCE MANUALS.

COORDINATION OF WORK

ALL NOTES APPLY TO ALL DRAWINGS AND ALL TRADES. IT IS THE RESPONSIBILITY OF ALL CONTRACTORS AND SUB-CONTRACTORS TO COORDINATE THE INSTALLATION OF THEIR WORK WITH THE INSTALLATION OF WORK BY ALL OTHER CONTRACTORS AND SUB-CONTRACTORS. THE REQUIREMENTS OF THE DRAWINGS, GENERAL REQUIREMENTS, AND ALL ITEMS OF THE CONTRACT DOCUMENTS ARE EQUALLY BINDING ON ALL CONTRACTORS AND SUB-CONTRACTORS. EACH CONTRACTOR IS REQUIRED TO MAINTAIN FULL SETS OF THE CONTRACT DOCUMENTS FOR HIS EMPLOYEE'S USE ON THE PROJECT AND ASSURE THAT ALL WORK IS PROPERLY COORDINATED AND INSTALLED WITH THE WORK OF OTHER CONTRACTORS AND SUB-CONTRACTORS.

CONTRACTOR SHALL SUPERVISE AND DIRECT THE WORK AND SHALL BE SOLELY RESPONSIBLE FOR ALL CONSTRUCTION MEANS, METHODS, TECHNIQUES AND SAFETY PROCEDURES AND FOR COORDINATING ALL PORTIONS OF THE WORK.

PROJECT SCOPE

THE PROJECT SCOPE OUTLINED IN THIS SET OF DOCUMENTS INCLUDES REPAIR AND REPLACEMENT OF AN EXISTING QUARRY TILE FLOOR IN THE KITCHEN AREA OF THE EXISTING MOSS JUSTICE CENTER.

WORK SHALL BE PERFORMED AS QUICKLY AND EFFICIENTLY AS POSSIBLE TO MINIMIZE KITCHEN SHUTDOWN TIME. THE PROPOSED SCHEDULE IS AS FOLLOWS:

1. REMOVE KITCHEN EQUIPMENT 1 DAY 2. FLOORING REPAIR/INSTALLATION 5 DAYS


2. FLOORING REPAIR/INSTALLATION 5 DAYS
3. FLOOR CURING 1 DAY
4. REINSTALLATION OF EQUIPMENT 1 DAY

CONTRACTOR SHALL BE RESPONSIBLE FOR TEMPORARY REMOVAL AND REINSTALLATION OF ALL KITCHEN EQUIPMENT INTERFERING WITH INSTALLATION OF THE NEW FLOOR.

VICINITY MAP



OVERALL PLAN

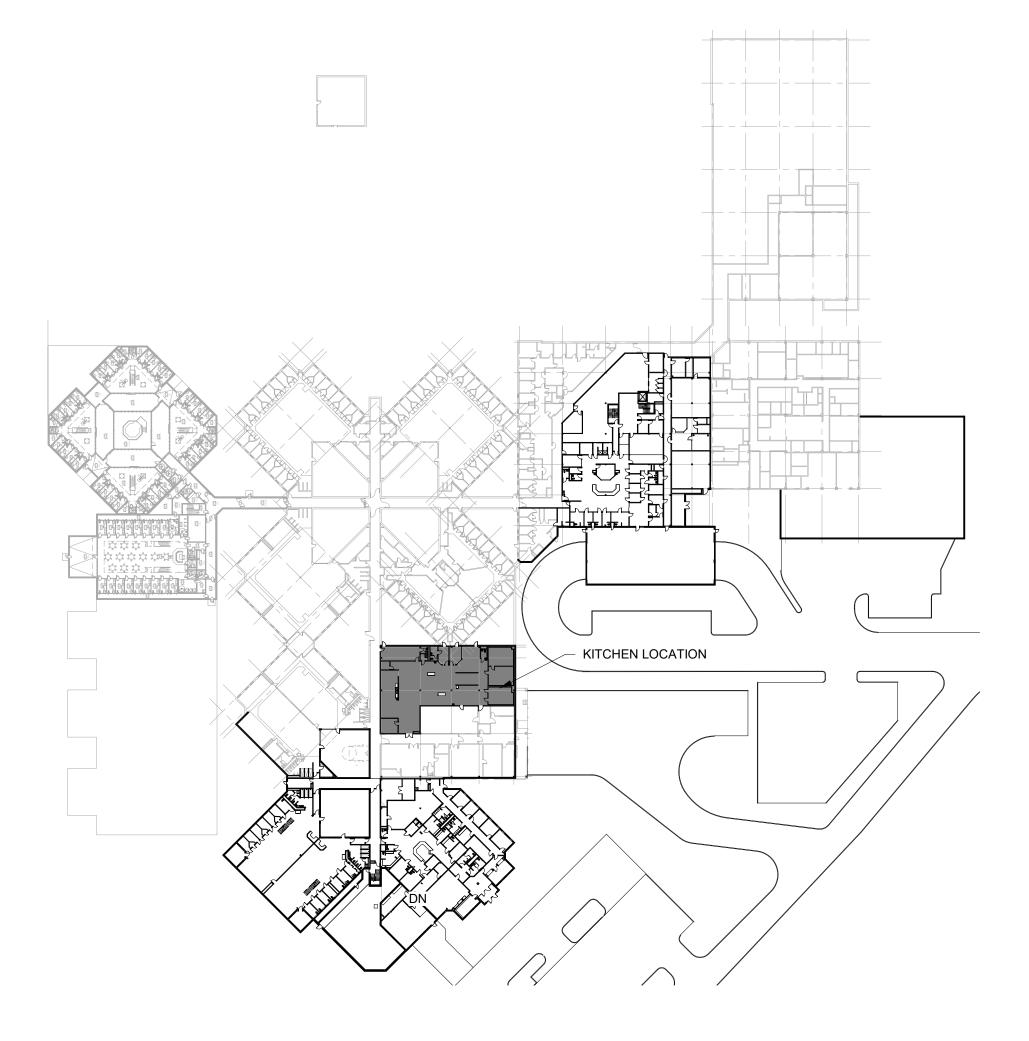


NUMBER	SHEET NAME	SHEET ISSUE DATE	CURRENT REVISION	CURRENT REVISION DATE
ΓITLE				
Τ1.01	TITLE SHEET	02/26/2025		
ARCHITEC A1.01	TURE FLOOR PLAN	02/26/2025		
SPECIFICA	ATIONS			
SP.01	SPECIFICATIONS (1 OF 3)	02/26/25		
SP.02	SPECIFICATIONS (2 OF 3)	02/26/25		
SP.03	SPECIFICATIONS (3 OF 3)	02/26/25		

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DP3

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Project



Project Number 25124
Drawn By MTP
Checked By MTP
Date 26 FEB 2025

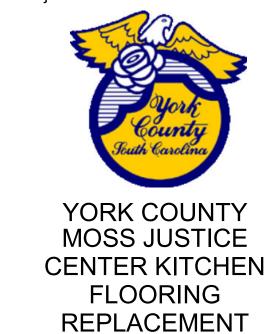Revisions

PROJECT CONTACTS

OWNER


YORK COUNTY CONTACT: SCOTT BURNS SCOTT.BURNS@YORKCOUNTY.GOV 803.818.5743 ARCHITECT

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Drawing

TITLE SHEET

T1.01

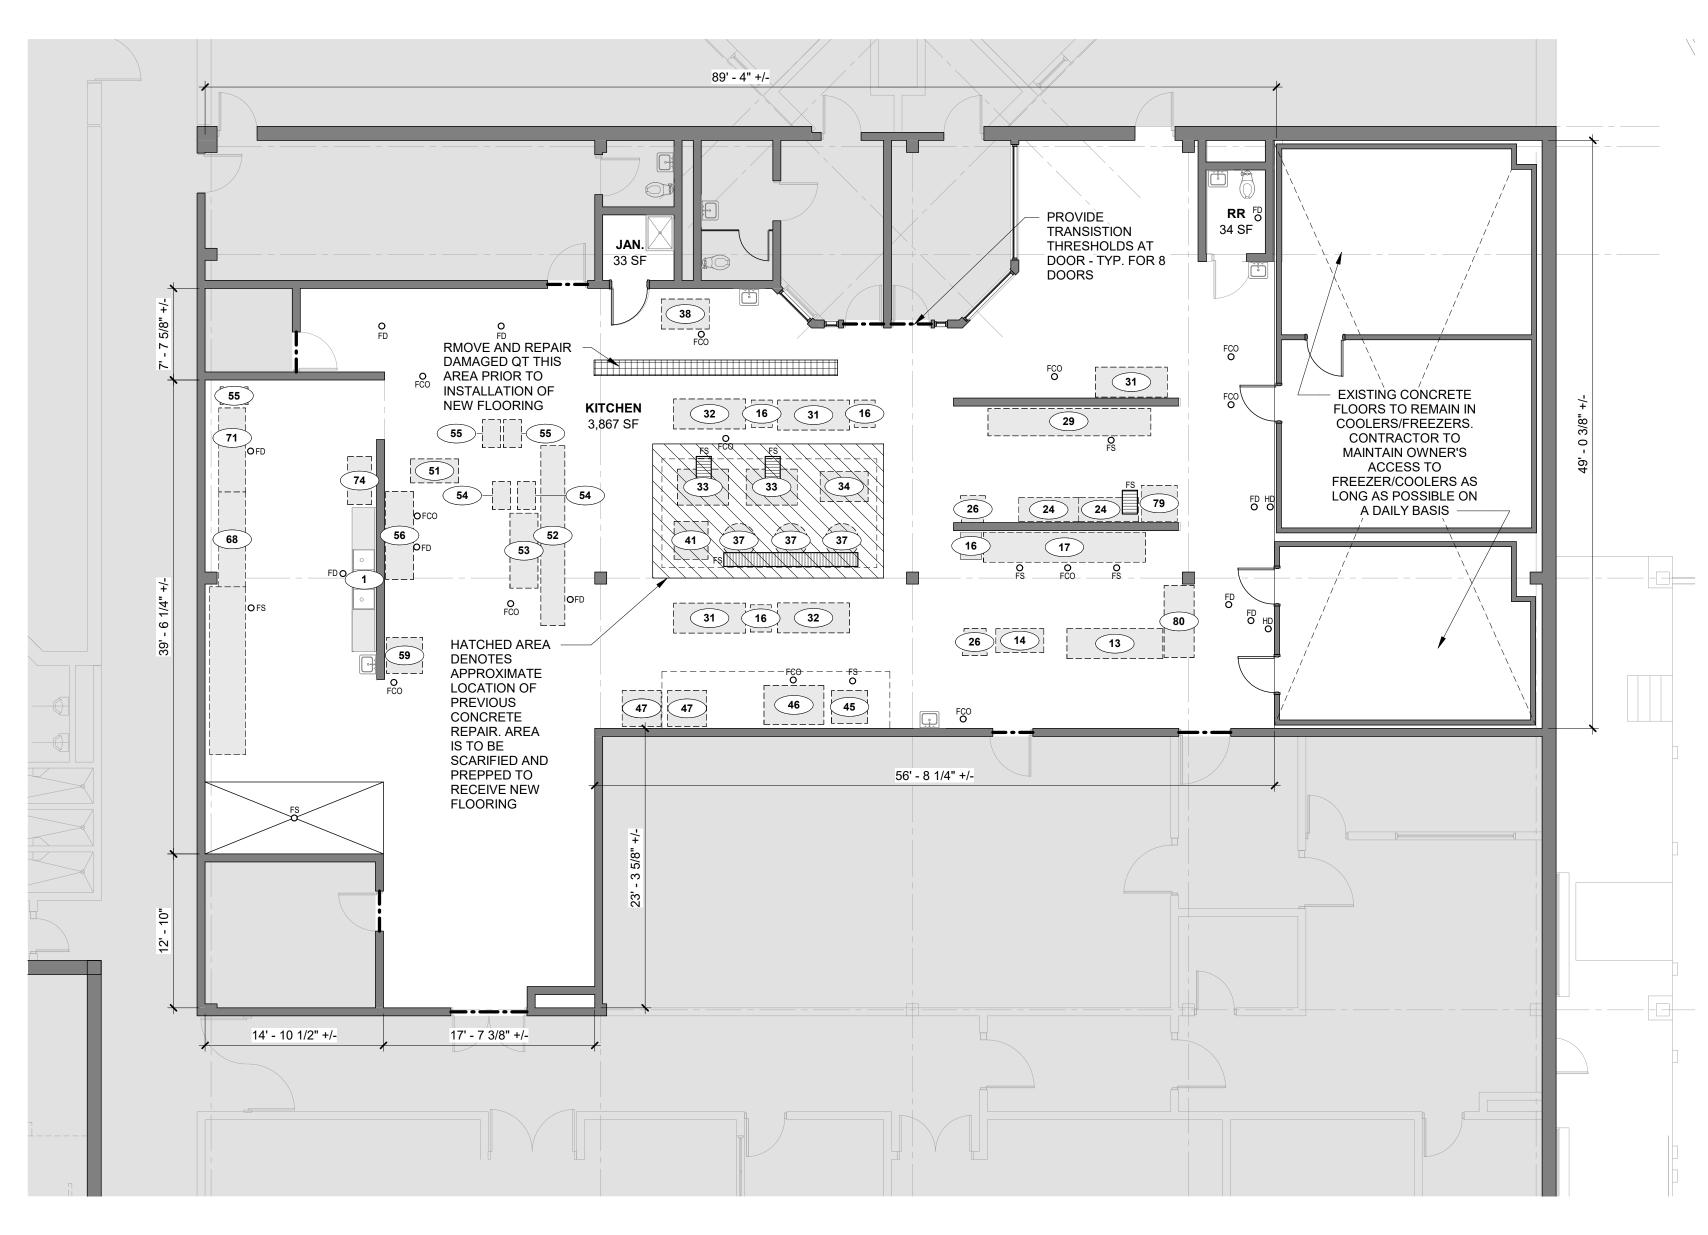

1 BLDG 3 - PROPOSED KITCHEN AREA \A1.01\textsquare 1/8" = 1'-0"

EQUIPMENT SCHEDULE

ITEM NAME 3 COMPARTMENT SINK BAKERS TABLE ATTACHMENT RACK PAN RACK MOBILE WORKTABLE WITH SINKS WORK TABLE MOBILE MIXER DISPOSER WORK TABLE MOBILE WORKTABLE WITH UTENSIL RACK TILTING SKILLET FRYER BATTERY KETTLE, STATIONARY ICE MACHNE GRIDDLE TOP RANGE PRESSURE STEAMER DECK OVEN CONVECTION OVEN HOT FOOD RACK, MOBILE TRAY ASSEMBLY CONVEYOR HOT FOOD TABLE PAN RACK MOBILE TRAY DISPENSER WORK COUNTER WITH SINK REFRIGERATOR SOILED DISHTABLE DISH MACHINE

> CLEAN DISHTABLE CLEAN POT RACK MIXER - SMALL

BAKERS TABLE - SMALL

*ALL KITCHEN EQUIPMENT SHOWN IS PROVIDED FOR PLANNING PURPOSES ONLY. CONTRACTOR SHALL BE RESPONSIBLE FOR CONFIRMING ALL FINAL EQUIPMENT REQUIRING TO BE TEMPORARILY RELOCATED AND ALL RELATED UTILITY CONNECTIONS.

GENERAL DEMOLITION NOTES

- A. ALL MATERIALS THAT HAVE BEEN DEMOLISHED SHALL BE REMOVED IMMEDIATELY AND DISPOSED OF PROPERLY. NO DEMOLISHED MATERIALS SHALL BE STOCKPILED ON SITE.
- B. PROTECT OWNER'S PROPERTY AND PERSONS AT ALL TIMES.
- C. ANY ITEMS NOT SHOWN TO BE DEMOLISHED THAT ARE DAMAGED SHALL BE REPAIRED OR REPLACED BY THE CONTRACTOR.
- D. COORDINATE ANY SYSTEMS SHUTDOWNS WHICH MAY BE REQUIRED WITH THE OWNER.
- E. PRIOR TO COMMENCING WITH THE DEMOLITION, THE CONTRACTOR SHALL ASCERTAIN FROM THE OWNER WHETHER OR NOT THE OWNER WISHES TO RETAIN ANY ITEMS. ANY SUCH ITEMS SHALL BE REMOVED WITH CARE SO AS TO PREVENT UNNECESSARY DAMAGE AND TURNED OVER TO THE OWNER.
- F. THE CONTRACTOR SHALL CONTROL AND LIMIT DUST RESULTING FROM DEMOLITION AND PREVENT THE SPREAD OF DUST TO THE REMAINING BUILDING.
- G. DEMOLITION INCLUDES REMOVAL OF ALL EXISTING DAMAGED FLOORING AND BASE NECESSARY TO FACILITATE THE NEW FLOORING INSTALLATION, WHETHER SPECIFICALLY INDICATED OR NOT, UNLESS NOTED OTHERWISE.

GENERAL FINISH NOTES

INDUSTRY STANDARDS.

- A. PROVIDE SAMPLES FOR ALL FINISHES FOR APPROVAL PRIOR TO ORDERING MATERIAL OR PROCEEDING WITH WORK.
- B. TEST SUBSTRATES FOR APPROPRIATE MOISTURE LEVELS PRIOR TO INSTALLING MATERIALS.
- C. INSTALL ALL MATERIALS IN ACCORDANCE WITH MANUFACTURER'S INSTRUCTIONS/RECOMMENDATIONS AND
- D. ALL FLOORING TRANSITIONS TO BE COMPLIANT WITH ADA AND LOCAL ACCESSIBILITY REQUIREMENTS. SHOULD REQUIREMENTS BE IN CONFLICT, THE MORE STRINGENT SHALL BE FOLLOWED.
- E. ALL FLOORING TRANSITIONS BETWEEN ROOMS TO OCCUR UNDER CENTERLINE OF DOOR IN CLOSED POSITION.
- F. IF SURFACES ARE NOT ACCEPTABLE TO RECEIVE FINISHES, CONTRACTOR SHALL HAVE SURFACES CORRECTED BEFORE BEGINNING FINISH APPLICATION.

GENERAL FLOOR PLAN NOTES

- A. GENERAL CONTRACTOR TO FIELD VERIFY ALL DIMENSIONS.
- B. NON-FIXED FURNITURE AND KITCHEN EQUIPMENT IS SHOWN FOR REFERENCE ONLY. NO NON-FIXED FURNITURE, FURNISHINGS OR EQUIPMENT ARE A PART OF THE CONSTRUCTION CONTRACT.

DETAILED SCOPE OF WORK

- CONTRACTOR TO TEMPORARILY REMOVE AND STORE EXISTING KITCHEN EQUIPMENT TO CLEAR THE KITCHEN FOR FLOORING INSTALLATION.
- REMOVE APPROXIMATELY 25 SF OF DAMAGED 8"X8" QUARRY TILE AND PREP APPROXIMATELY 200 SF OF PREVIOUS POURED CONCRETE FLOOR REPAIR.
- EXISTING QT JOINTS IN BASE TO BE FILLED & CHIPPED BASE TO BE PATCHED.
- TAP FLOOR AND REMOVE ANY LOOSE QUARRY TILE & FILL IN WITH URETHANE CONCRETE (APPROXIMATELY 200 SF
- EXISTING QUARRY TILE JOINTS IN BASE TO BE FILLED &
- CHIPPED. BASE TO BE PATCHED
- SCRUB FLOOR WITH A DEGREASER AND CLEAN PREP FLOOR & BASE BY GRINDING
- PRE-FILL FLOOR JOINTS AND BASE JOINTS WITH URETHANE CONCRETE
- INSTALL URETHANE CONCRETE ON FLOOR AND BASE & BROADCAST AGGREGATE. BASIS OF DESIGN: EUCLID
- TOPCOAT WITH A HIGH PERFORMANCE CEMENTITIOUS URETHANE FLOOR SEALER
- REINSTALL ALL TEMOPORARILY REMOVED KITCHEN

FLOORING SPECIFICATION

REFER TO PRODUCT DATA SHEETS ON SP.01, SP.02, AND SP.03

BASIS OF DESIGN - ALL PRODUCTS ARE AS MANUFACTURED BY CARBOLINE GLOBAL, INC. OR APPROVED EQUAL. COLORS TO BE SELECTED BY OWNER FROM MANUFACTURER'S STANDARD COLOR SELECTIONS:

PRIME INTEGRAL EPOXY BASE - STERI-PRIME

INSTALL INTEGRAL EPOXY BASE - STERI-COVE GEL

PATCHING FLOOR WHERE QUARRY TILE IS NOT BONDED HOLLOW -SHOCK-CRETE HD

BODY COAT - SHOCK-CRETE SL 2

EQUIPMENT.

BROADCAST INTO SHOCK-CRETE SL2 - FILLER 0904 (20-40 MESH SAND) TO CREATE TEXTURE

TOPCOAT - SHOCK-CRETE TCUV

Seal

ARCHITECTS

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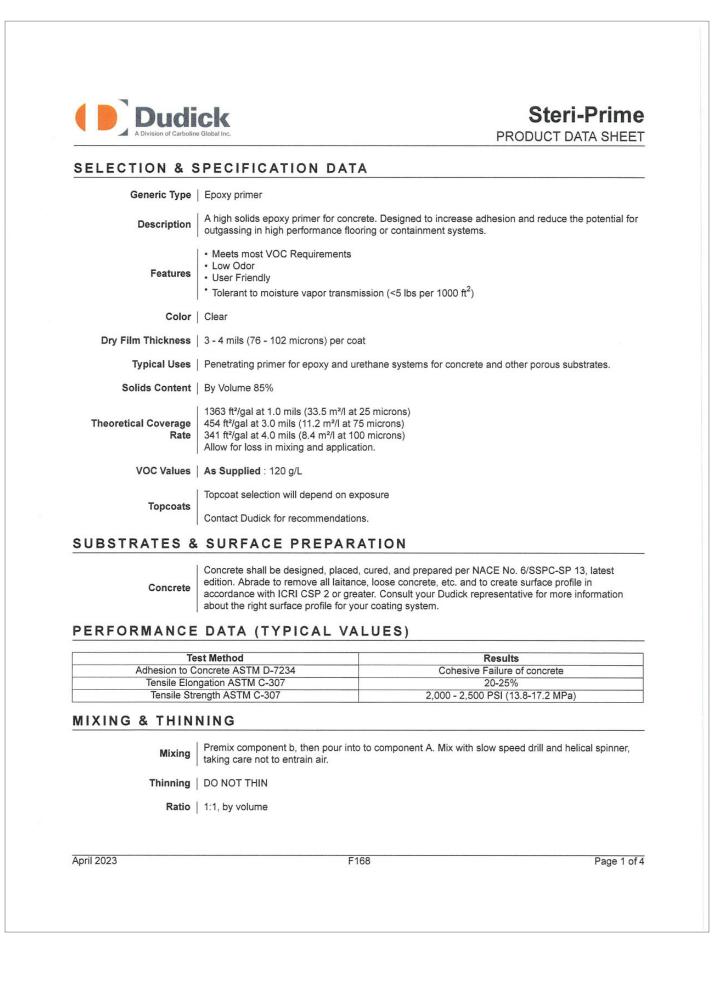


Project Number 25124 Drawn By MTP MTP Checked By 26 FEB 2025 Date

Revisions

Drawing

FLOOR PLAN



SELECTION & SPECIFICATION DATA

Generic Type | 100% solids thixotropic epoxy coating

recommended by Dudick.

Low emitting material

Low installation odor

Educational Facilities

Food & Beverage Facilities

Coverage Rate 3/16" Thickness (1" radius) - 27 lineal feet at 6" height

Clean Rooms

Laboratories

VOC Values | As Supplied : 45 g/L

SUBSTRATES & SURFACE PREPARATION

Low VOC's


Typical Uses

December 2024

Features • Meets SCAQMD Rule 1113 for VOC content

· Commercial/Institutional Kitchens

Pharmaceutical & Research Facilities

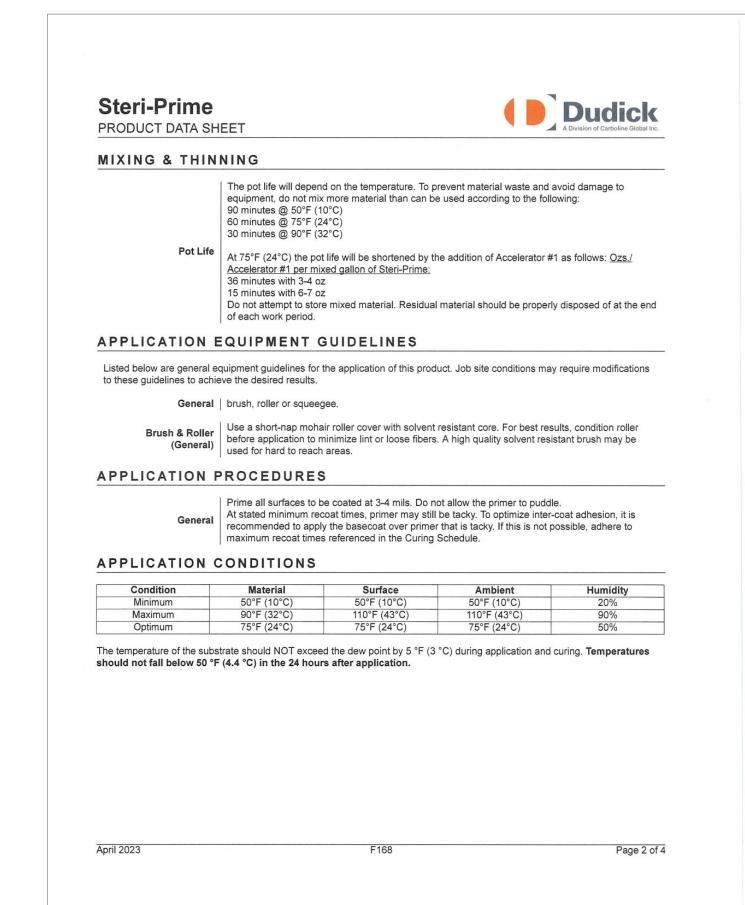

mix thoroughly for 2-3 minutes to achieve a uniform color and consistency.

blended color quartz (trowel grade), solid color quartz (trowel grade) or EA-1 Filler.

Concrete must always be primed to aid to reduce the potential for outgassing and to promote

Use a disposable brush to apply a thin coat on the vertical surface as well as the appropriate

dried before the cove mortar is applied, an additional tack coat must be re-applied.)

horizontal area which will be part of the seamless cove base.

cure overnight and repeat (if necessary) for second coat.

Steri-Cove Gel

PRODUCT DATA SHEET

MIXING & THINNING

Part A: 85 oz (2.5 liters)

50 lbs (22.7 kg) of aggregate

20-25 minutes @ 70°F (21°C)

Do not allow the primer to puddle.

Ratio Part B: 43 oz (1.27 liters)

of each work period.

coverage.

Grout Coat:

and high substrate temperatures. Overtrowelling may also lead to blisters.

Double priming, shading or evening application may be required. Consult a Dudick representative.

APPLICATION PROCEDURES

APPLICATION CONDITIONS

December 2024

Steri-Cove Gel

PRODUCT DATA SHEET

Steri-Cove Gel is an epoxy system designed for installation as integral cove base @ 1/16" to 1/4"

Meets California Department of Public Health CDPH/EHLB Standard Method Version 1.2 2017.

For solid colors use Steri-Cove Gel color packs with EA-1 Filler. Steri-Cove Gel color packs are

Coverage estimated for 1 gallon of mixed resin combined with 50 lbs of EA-1 Filler or 25 mesh

Concrete must be prepared mechanically to remove surface laitance. Oils, grease or other

contaminant must be removed prior to surface preparation. Concrete must free of curing

Concrete or the visual standard, CSP 3 from the International Concrete Repair Institute. The prepared

completely removed with the first mechanical preparation procedure.

compounds and form release agents. Surface texture should be similar to 60-80 grit sandpaper

surface should have a minimum tensile strength of 250 PSI per ASTM D4541. Additional surface

preparation will be required if a 60-80 grit texture is not achieved and the surface laitance not

Color Quartz trowel grade fillers added, yielding approximately 3.25 gallons of mixed mortar.

Color matched to the Dudick Architectural Solid Color chart. Using just the clear resin and pre-blended

color quartz allows for a virtually unlimited color options if needed.

Primer | Steri-Prime, Primer 67LV or others as recommended by Dudick.

1/8" Thickness (1" radius) - 47 lineal feet at 4" height

1/8" Thickness (1" radius) - 33 lineal feet at 6" height

3/16" Thickness (1" radius) - 40 lineal feet at 4" height

Description thick. For use with Dudick Steri-Flor, Steri-Quartz, Steri-Flake systems, and other systems as

Contributes toward satisfying credit for low emitting material under LEED 4.1

Compliance Certificates Available Upon Request



Important: With all epoxies after priming and before each additional coat, examine the surface for amine blush (oily film). If

Dudick flooring systems can be built to meet or exceed the requirements of Static or Dynamic

General Coefficient of Friction testing per installation to meet static coefficient of friction requirements for ANSI B101.1 of >0.6 and dynamic coefficient of friction (DCOF)* – Wet ANSI A326.3 of >0.42.

Cleanup Use S-10 Cleaning Solvent to clean tools and equipment. Acetone and MEK may also be used. DO NOT USE LACQUER THINNER.

Safety Read and follow all caution statements on this product data sheet and on the SDS. Employ normal safety precautions. Keep container closed when not in use.

When 1 x 50lb bag of EA-1 Filler or 25 mesh color quartz is added, a 1 gallon kit yields

When 5 x 50lbs bags of EA-1 Filler or 25 mesh color quartz are added, a 5 gallon kit yields

When properly stored in their original, unopened containers. Storage in direct sunlight or excessive

All products should be stored in a cool, dry area, away from open flames, sparks, or other hazards.

Storage | Warning: All Dudick products classified by DOT with white, yellow or red labels must not be mixed

Steri-Cove Gel

PRODUCT DATA SHEET

Maximum Recoat Time



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Seal




25124 26 FEB 2025

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Project Number Drawn By Checked By Date Revisions



CURING SCHEDULE

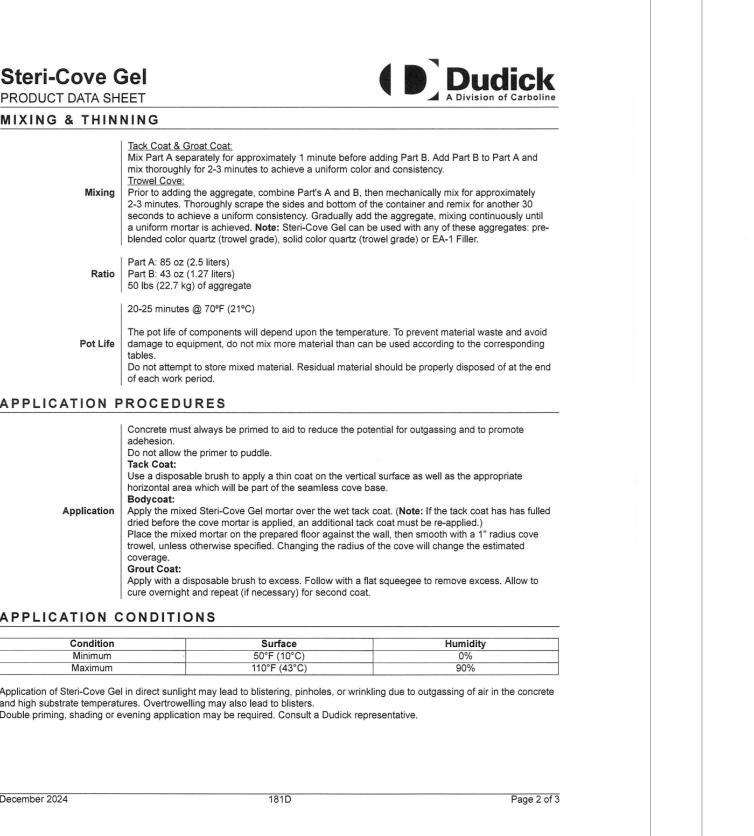CLEANUP & SAFETY

WARRANTY

otherwise indicated.

December 2024

present, remove by washing with warm water and detergent.

TESTING / CERTIFICATION / LISTING

PACKAGING, HANDLING & STORAGE

Packaging 5 Gallon Kit:

Part A - 0.65 gal (1.89 liters)

Part B - 0.35 gal (1.89 liters)

Part A - 3.25 gal (9.46 liters)

Part B - 1.75 gal (9.46 liters)

approximately 16.25 mixed gallons

12 months at 50°F-75°F (10°C-24°C)

heat will reduce working time and shelf life.

or stored together as an explosive reaction can occur.

To the best of our knowledge the technical data contained herein is true and accurate on the date of publication and is subject

to change without prior notice. User must contact Carboline Company to verify correctness before specifying or ordering. No


guarantee of accuracy is given or implied. We guarantee our products to conform to Carboline quality control. We assume no


responsibility for coverage, performance, injuries or damages resulting from use. Carbolines sole obligation, if any, is to replace

or refund the purchase price of the Carboline product(s) proven to be defective, at Carbolines option. Carboline shall not be liable for any loss or damage. NO OTHER WARRANTY OR GUARANTEE OF ANY KIND IS MADE BY CARBOLINE, EXPRESS OR

IMPLIED, STATUTORY, BY OPERATION OF LAW, OR OTHERWISE, INCLUDING MERCHANTABILITY AND FITNESS FOR A PARTICULAR PURPOSE. All of the trademarks referenced above are the property of Carboline International Corporation unless

approximately 3.25 mixed gallons

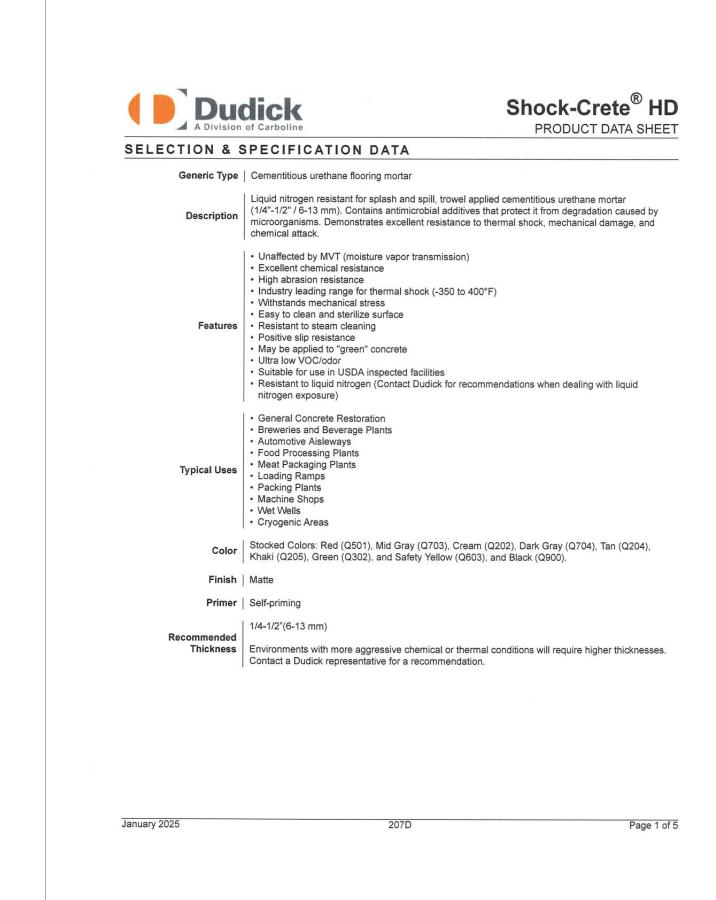


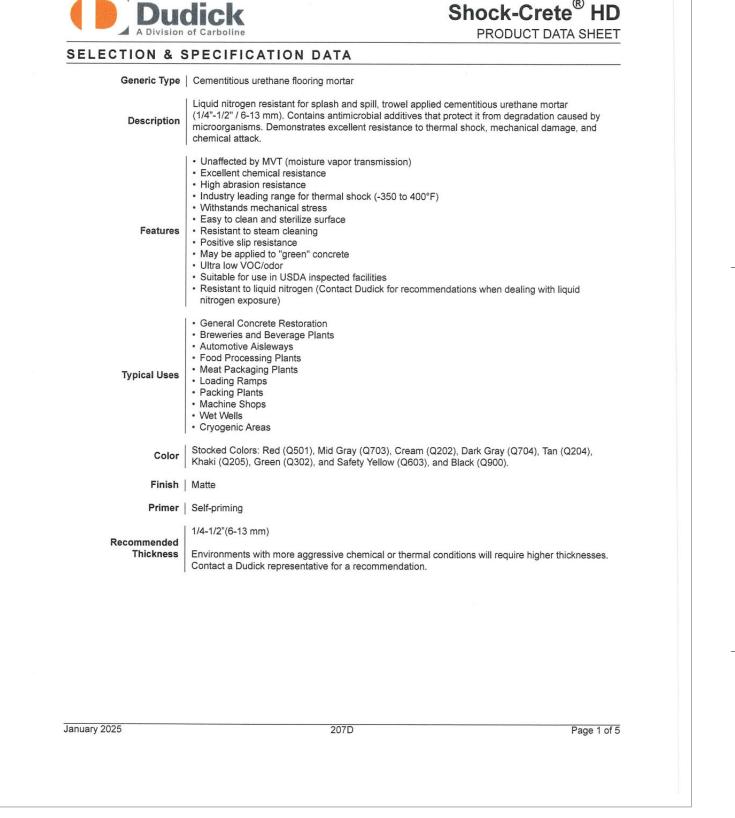


Drawing


SPECIFICATIONS (1 OF 3)

LECTION & S	SPECIFICATION DATA	
Coverage Rate	Small Kit 20 ft² (1.9 m²) at 1/4" (6 mm) 15 ft² (1.4 m²) at 3/8" (10 mm) 10 ft² (.9 m²) at 1/2" (13 mm) Tote Kit 12,000 ft² (1,115 m²) at 1/4" (6 mm) 8,250 ft² (766.5 m²) at 3/8" (10 mm) 5,500 ft² (511 m²) at 1/2" (13 mm) For thicknesses greater than 1" (25 mm) extend using pea gravel. Add 16 lbs. (7.3 kg) of pea gravel per unit to yield 0.57 cubic feet (0.02 cubic meters).	
VOC Values	As Supplied : 35 g/L	
Ory Temp. Resistance -350°F to 400°F (-212°C to 204°C)		
Limitations	While this product is resistant to liquid nitrogen exposure with sustained or frequent cyclic exposure, minimal discoloration and visible hairline cracks are possible. This does not effect the ability for it to protect the concrete substrate.	
Chemical Resistance	Organic Acids Dilute Inorganic Acids Alkali Solutions Salts Oils Aliphatic Solvents	
Topcoats	Shock-Crete Topcoat, Shock-Crete TCUV, Sealer 985 or as recommended by your Dudick representative.	
UBSTRATES 8	SURFACE PREPARATION	
Concrete	Concrete must be prepared mechanically to remove surface laitance. Oils, grease or other contaminant must be removed prior to surface preparation. Concrete must free of curing compounds and form release agents. Surface texture should be similar to 40-60-grit sandpaper or the visual standard, CSP-5 from the International Concrete Repair Institute with exposed pea gravel. The prepared surface should have a nominal tensile strength of 250 PSI per ASTM D-7234. All control joints must be honored. Anchor grooves must be cut on both sides of such joints. Welded joints and cracks in the concrete may be coated, but if movement occurs the coating will crack with the movement of the concrete All concrete substrates must be checked for moisture prior to product application using the Plastic Sheet Test, ASTM D-4263. Additional surface preparation will be required if a 40-60 grit texture with exposed pea gravel is not achieved and the surface laitance not completely removed with the first mechanical preparation procedure.	
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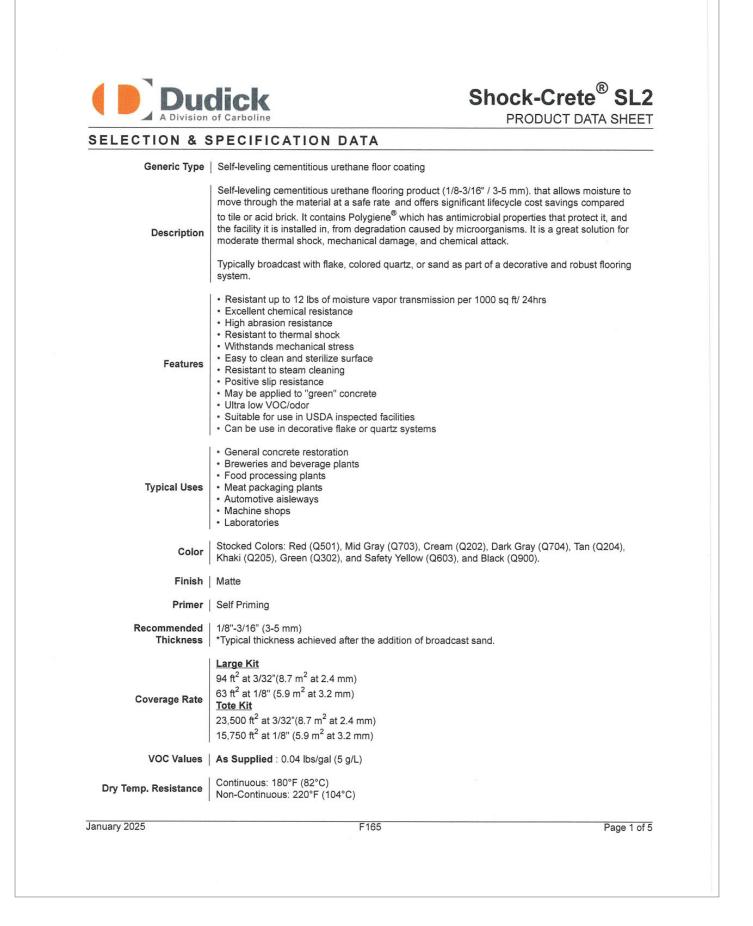
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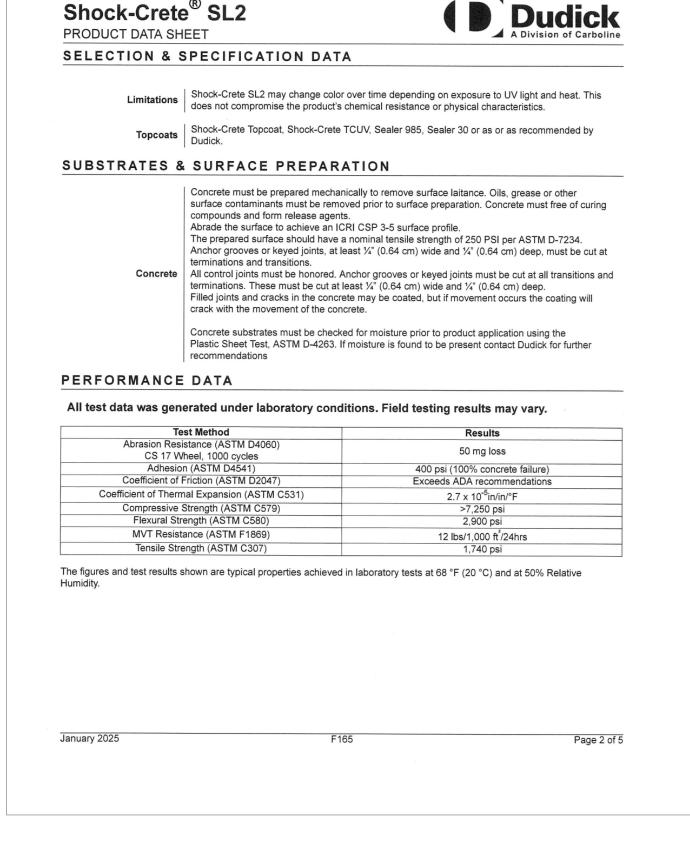
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Revisions

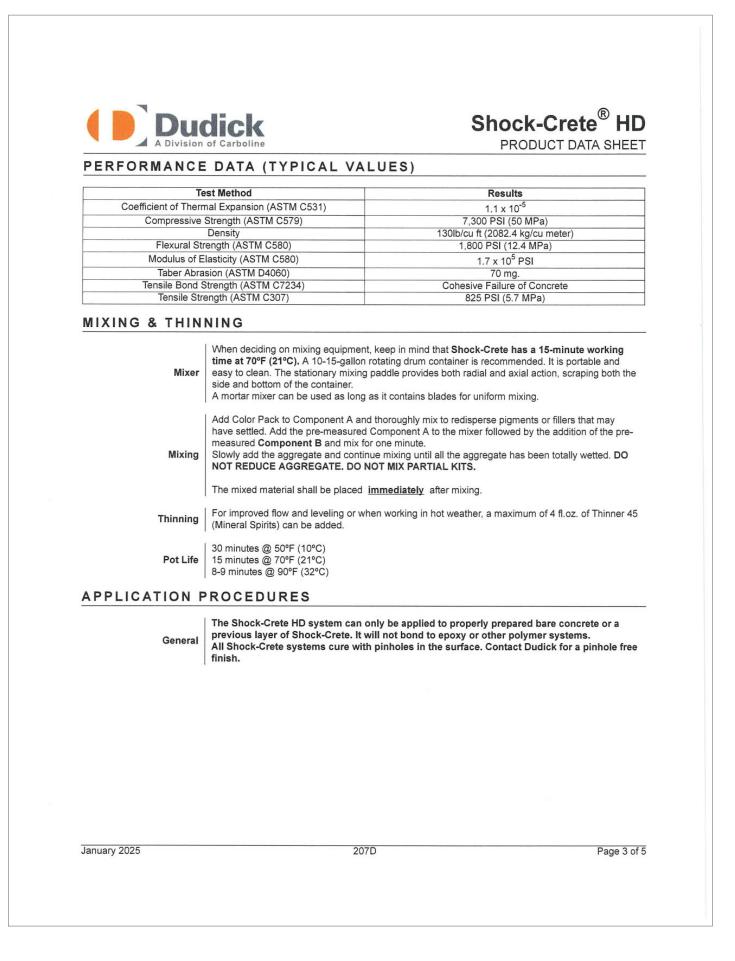
Drawing

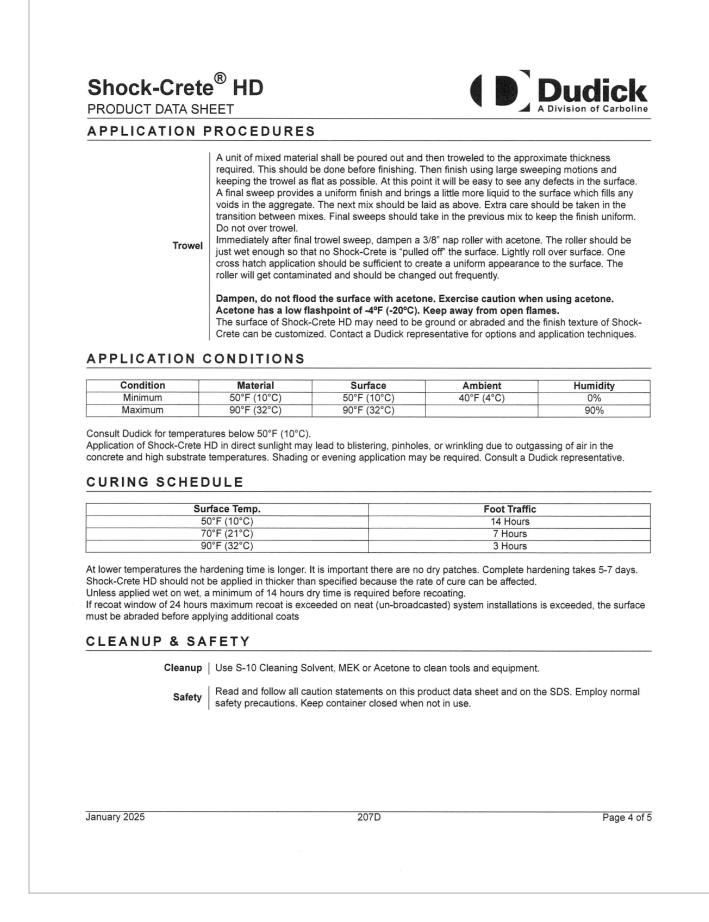
SPECIFICATIONS (2 OF 3)



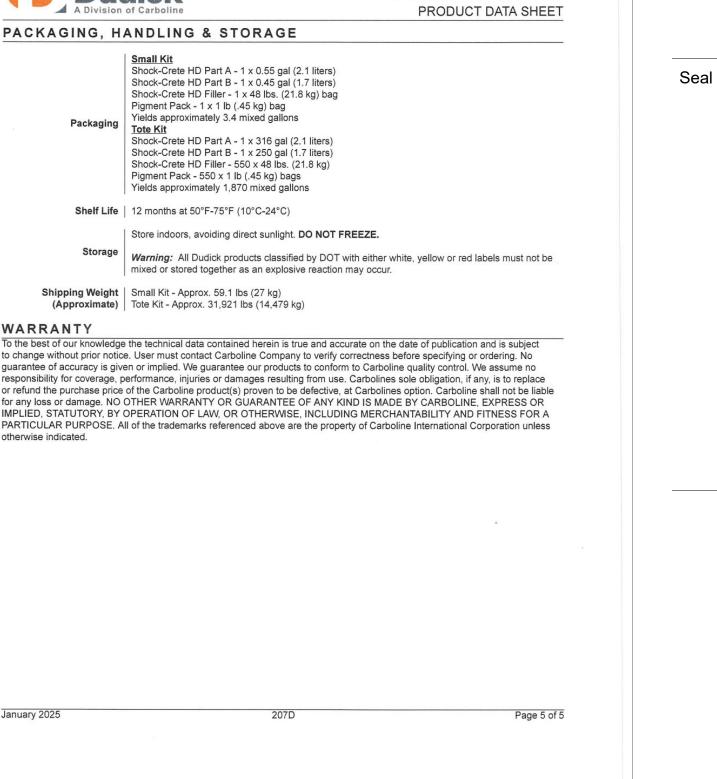

Shock-Crete[®] SL2

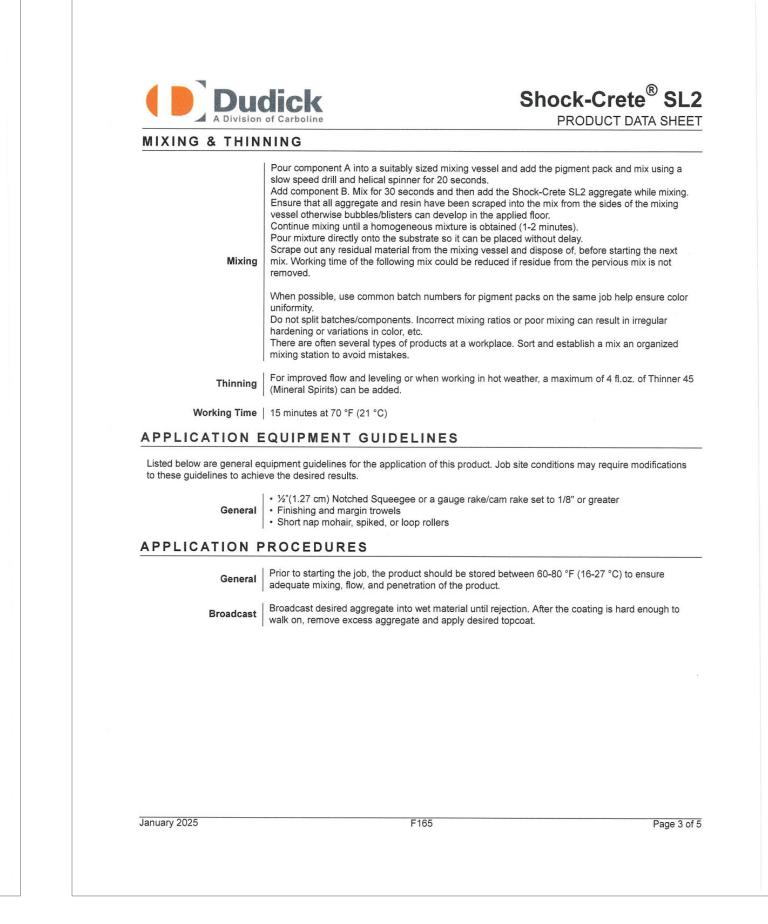


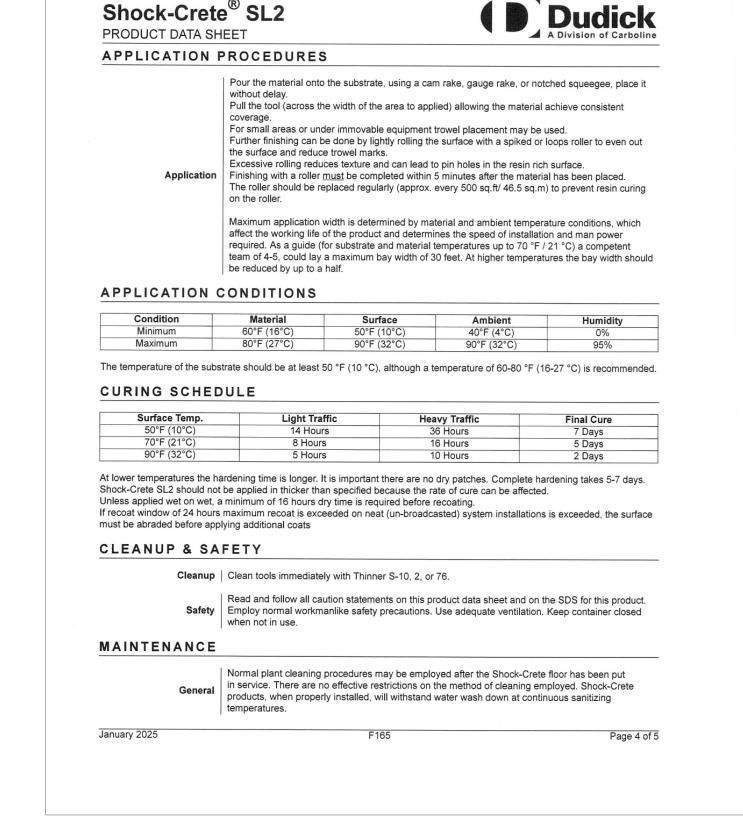


January 2025

A Division	dick of Carboline	Shock-Crete [®] SL. PRODUCT DATA SHEE	
CKAGING, H	ANDLING & STORAGE		
Packaging	Large Kit Shock-Crete Part A - 1 x 1.20 gal (4.5 liters Shock-Crete Part B - 1 x 0.98 gal (3.7 liters Shock-Crete SL2 Filler - 1x 40 lb (18 kg) bap Pigment Pack - 1 x 1 lb (.45 kg) bag Yields approximately 3.95 mixed gallons Tote Kit Shock-Crete Part A - 1 x 300 gal (1135.6 lit Shock-Crete Part B - 1 x 245 gal (927.4 lite Shock-Crete SL2 Filler - 250 x 40 lb (18 kg Pigment Pack - 250 x 1 lb (.45 kg) bags Yields approximately 987 mixed gallons	ers)	
Shelf Life	12 months in unopened container		
torage Temperature & Humidity			
Shipping Weight (Approximate)			
lash Point (Setaflash)	Part A: >200 °F (93 °C) Part B: 351 °F (177 °C)		
ARRANTY			
hange without prior notic rantee of accuracy is giv joonsibility for coverage, p efund the purchase price any loss or damage. NO LIED, STATUTORY, BY	ce. User must contact Carboline Company to ven or implied. We guarantee our products to performance, injuries or damages resulting frre or of the Carboline product(s) proven to be defi- OTHER WARRANTY OR GUARANTEE OF OPERATION OF LAW, OR OTHERWISE, IN	and accurate on the date of publication and is subject verify correctness before specifying or ordering. No conform to Carboline quality control. We assume no om use. Carbolines sole obligation, if any, is to replace ective, at Carbolines option. Carboline shall not be liable ANY KIND IS MADE BY CARBOLINE, EXPRESS OR CLUDING MERCHANTABILITY AND FITNESS FOR A e property of Carboline International Corporation unless	
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Seal

DP:
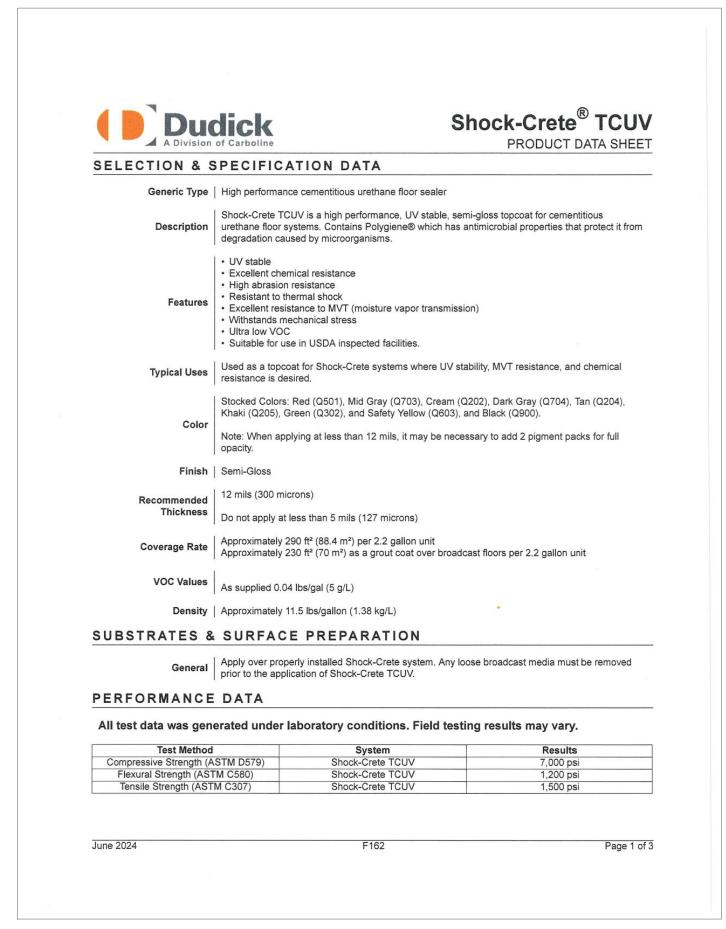
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SPECIFICATIONS (3 OF 3)

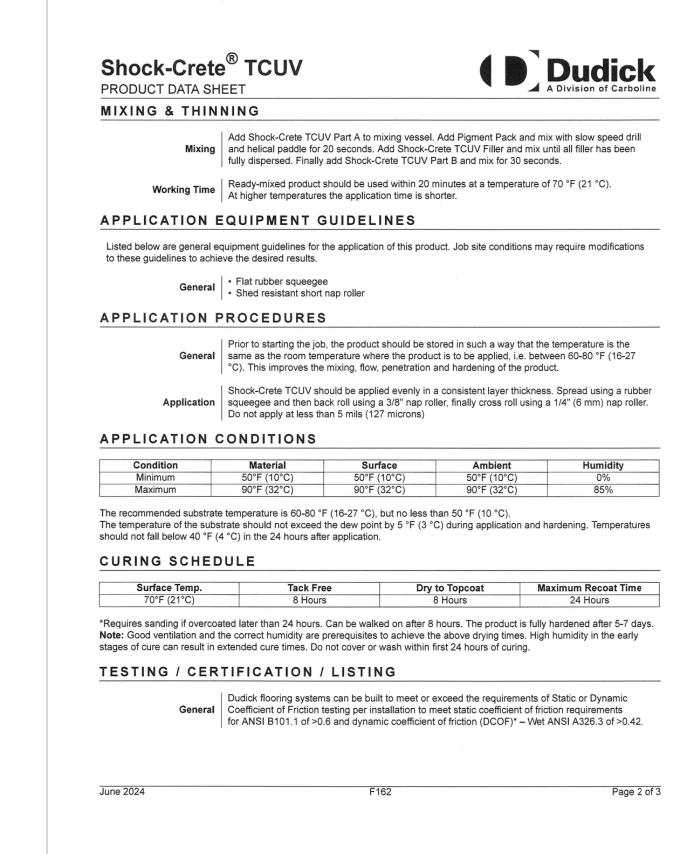SP.03